

— 5.00 — EXISTING CONTOUR RL 2.40 DESIGN SPOTLEVEL EXISTING SPOTLEVEL DENOTES NEW SURFACE INLET PIT, REFER TO PLAN FOR NEW U.P.V.C. STORMWATER DRAINAGE PIPE (SIZE AS SHOWN ON PLAN) LAID AT 1.0% MIN. FALL (UNO) TO OUTLET IN ACCORDANCE WITH COUNCILS SPECIFICATIONS NEW CONCRETE ENCASED PIPE, (SIZE AS SHOWN ON PLAN) LAID AT 0.5% MIN. FALL (UNO) TO OUTLET IN ACCORDANCE WITH COUNCILS SPECIFICATIONS APPROXIMATE POSITION OF EXISTING STORMWATER DRAINAGE PIPE DENOTES DOWNPIPE DIRECTION OF SURFACE FALL — · — · — BOUNDARY LINE EXISTING FENCE EXISTING SEWER SERVICE EXISTING POWER POLE EXISTING GAS METER EXISTING TELECOMMUNICATIONS PIT EXISTING STOP VALVE EXISTING SEWER INSPECTION POINT EXISTING BOLLARD EXISTING TREE

LEGEND

#### NOTES

THE POSITION OF ALL EXISTING SERVICES SHOWN SHOULD BE REGARDED AS APPROXIMATE ONLY AND NOT NECESSARILY COMPREHENSIVE. IT IS THE CONTRACTOR'S RESPONSIBILITY TO DETERMINE THE EXACT SERVICE LOCATIONS AND INFORM ALL AUTHORITIES PRIOR TO ANY EXCAVATION.

DURING CONSTRUCTION, THE STRUCTURE SHALL BE MAINTAINED IN A STABLE CONDITION AND NO PART OF THE STRUCTURE SHALL BE OVER-STRESSED. TEMPORARY STRUCTURES, FORMWORK, FALSEWORK, TEMPORARY BRACING, SHORING AND THE LIKE SHALL BE THE SOLE RESPONSIBILITY OF THE CONTRACTOR.

ALL HANDRAILS, IF REQUIRED, ARE TO ARCHITECT'S LOCATION AND DETAILS AND SHALL COMPLY WITH AS1684.

BENCHMARKS TO BE PROVIDED PRIOR TO COMMENCEMENT OF CONSTRUCTION.

EXISTING CONTOURS ARE SHOWN AT 0.50m INTERVALS.

TREATMENT OF ALL EXPOSED / DISTURBED AREAS TO ARCHITECT'S DETAILS.

DETAIL OF LANDSCAPING IS TO TAKE INTO CONSIDERATION OVERLAND FLOW PATHS

ALL FENCES ARE TO BE DETAILED WITH 100mm GAP UNDER OR TO BE NON SOLID FENCES TO ALLOW WATER FLOW.


WHERE SITE IS IN CUT ADJACENT TO SITE BOUNDARY, TOP OF RETAINING WALLS TO BE CONSTRUCTED FLUSH WITH EXISTING SURFACE OF NEIGHBORING PROPERTIES TO AVOID IMPOUNDING WATER ON NEIGHBORING PROPERTIES.



BASEMENT - STORMWATER DRAINAGE PLAN

### NOT FOR CONSTRUCTION

**DRAWING STATUS** SHEET SIZE CLIENT PROJECT This drawing is the property of Lindsay Dynan DRAFT COPY **NEWCASTLE** BRANCOURT NOMINEES PTY LTD MIXED USE DEVELOPMENT and must not be retained, 5 Newton Street Broadmeadow NSW 2292 copied or used without PROJ MANAGER DRAFTSMAN DESIGNER SCALE SUSTAINABLE the consent of the company Phone - 02 4941 9900 Facsimile - 02 4957 7507 990 HUNTER STREET S.Z. 1:200 Email - mail@lindsaydynan.com.au 18/08/16 | M.B. | M.M. | M.M. | RE-ISSUED FOR DA TITLE Web - www.lindsaydynan.com.au PROJECT REF No. NEWCASTLE WEST, NSW DRAWING No. REVISION B | 07/04/16 | M.M. | M.M. | M.M. | AMENDED FOR DA SUBMISSION **BASEMENT** Quality Copyright A | 03/03/16 | S.Z. | M.M. | M.M. | ISSUED FOR DEVELOPMENT APPLICATION ✓ Management CONSULT AUSTRALIA 12120 C DA01 STORMWATER DRAINAGE PLAN Lindsay Dynan Sydney I Perth I Newcastle I Central Coast as date of issue REV DATE DRN CHK APP DRAWING STATUS

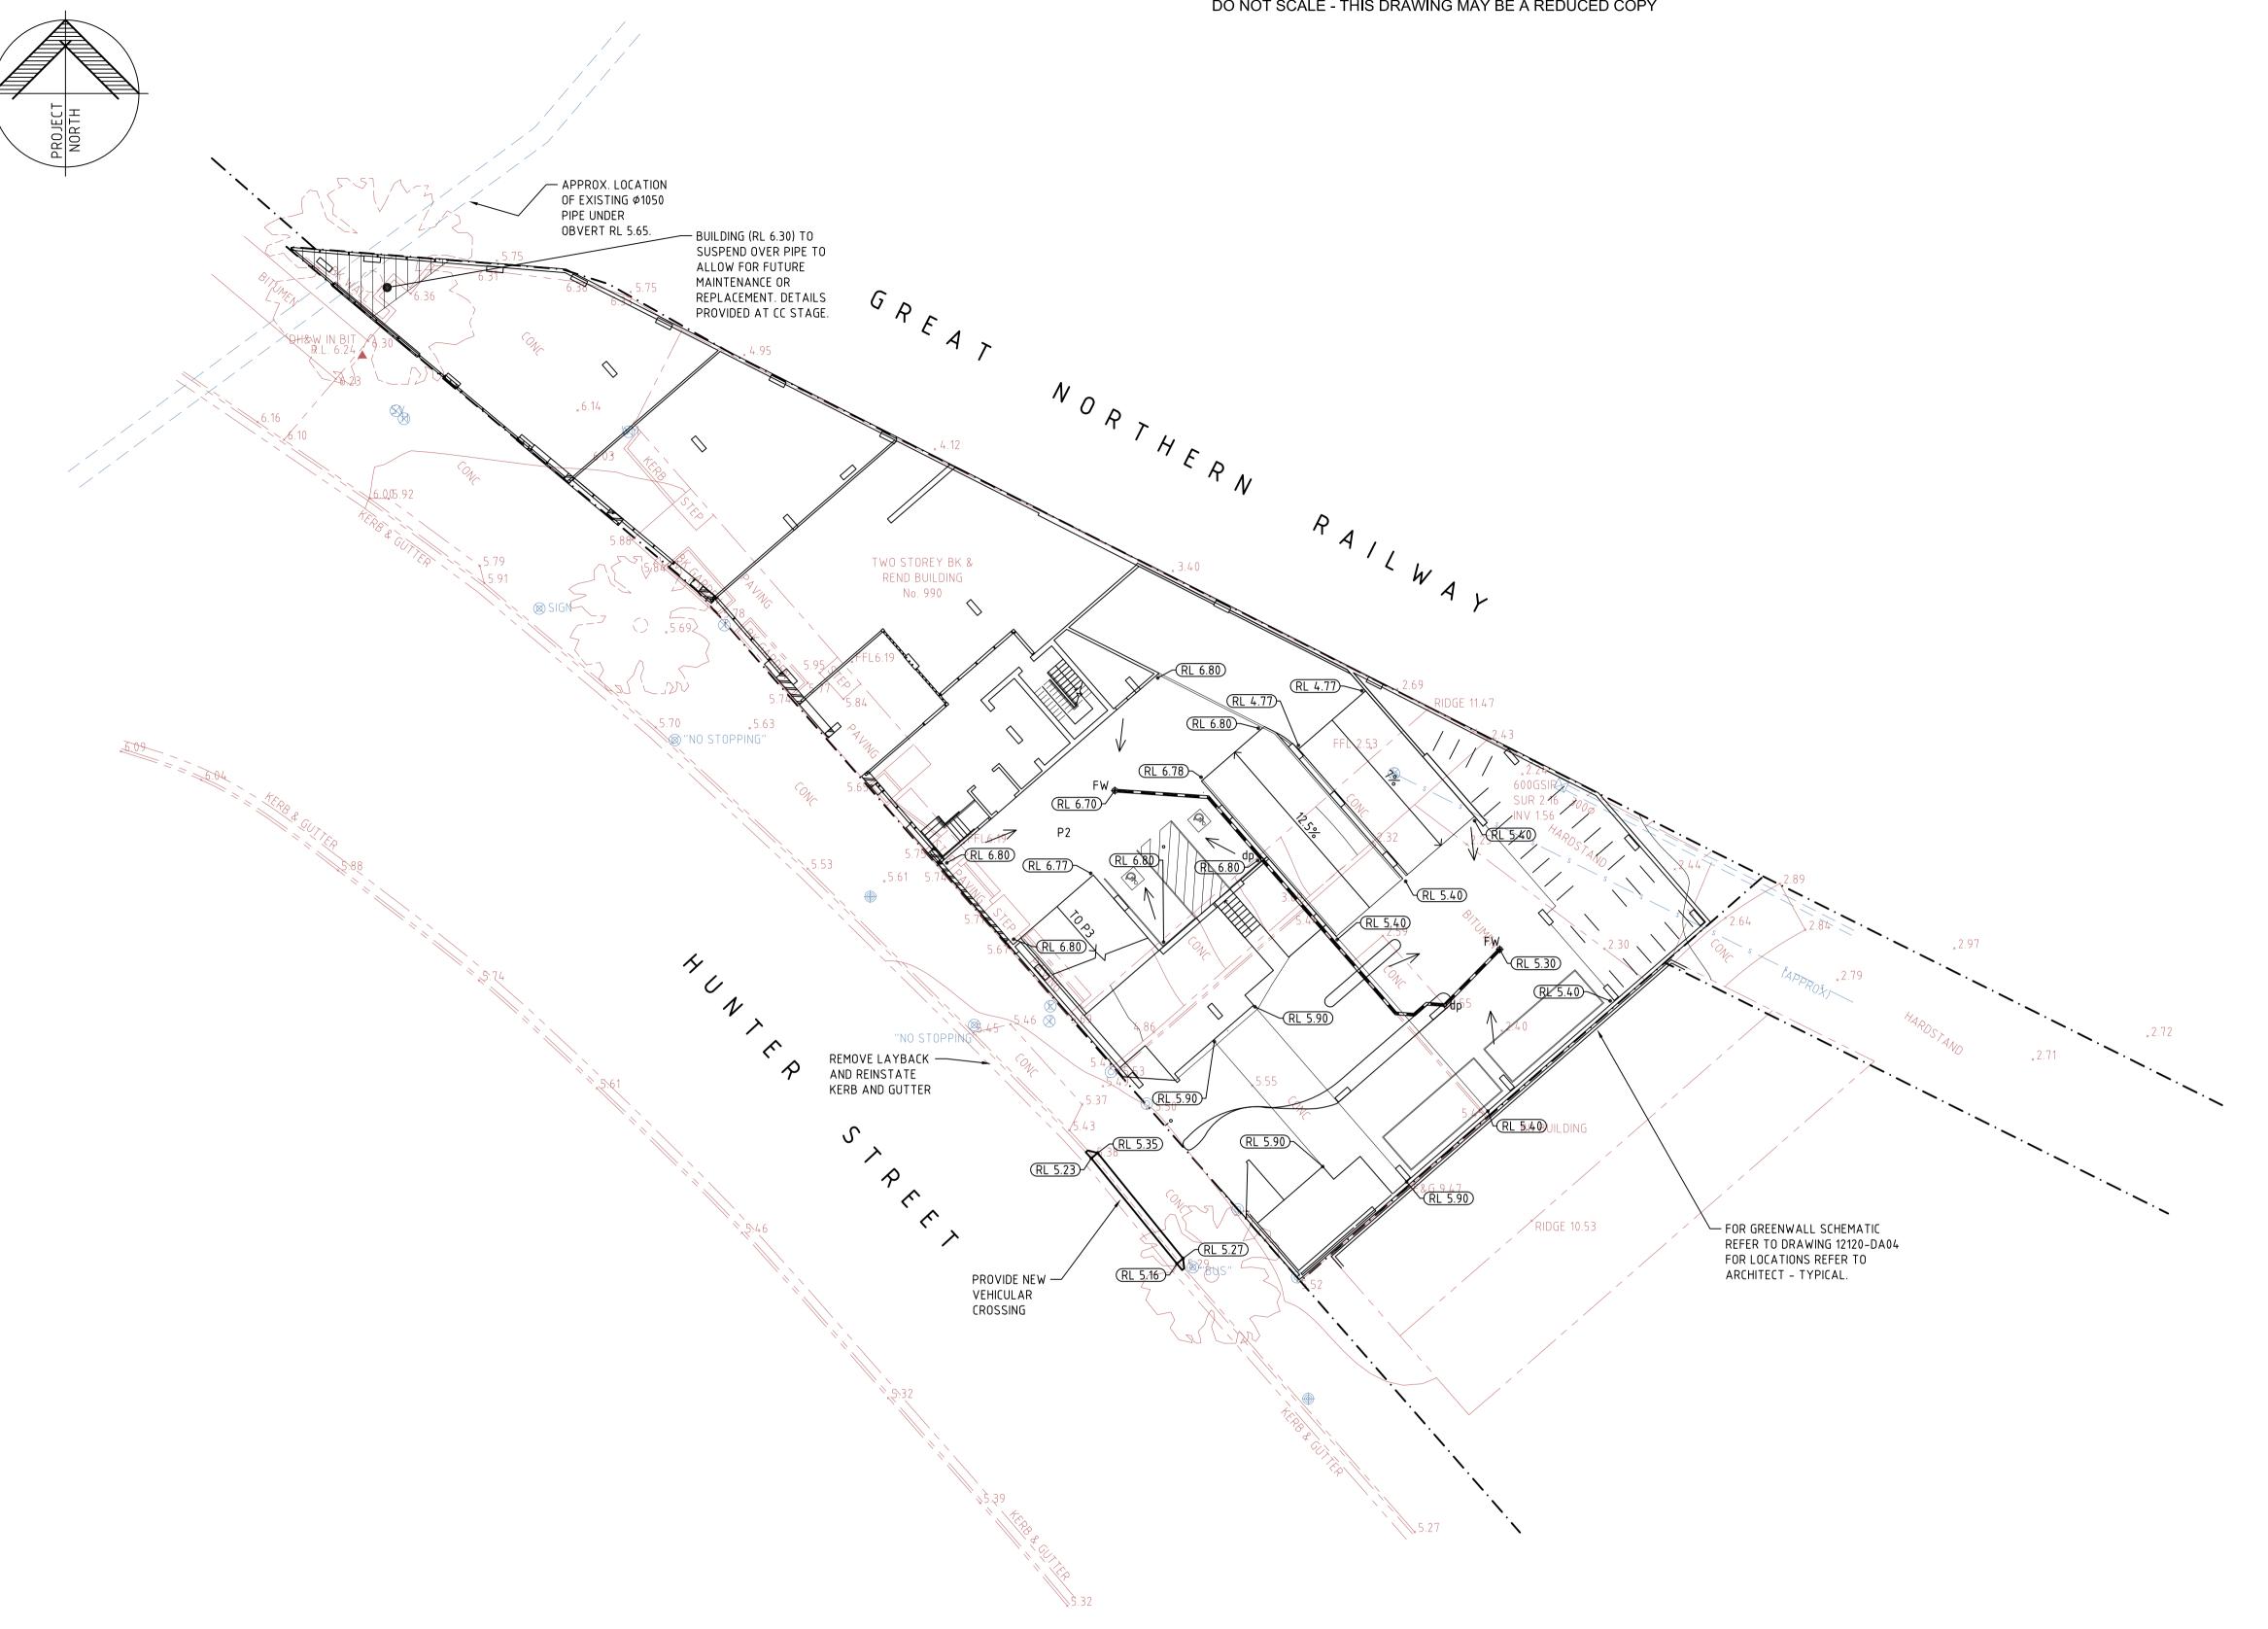

	LEGEND
5.00	EXISTING CONTOUR
RL 5.40	DESIGN SPOTLEVEL
× 5.55	EXISTING SPOTLEVEL
<b>⊕</b> FW	DENOTES NEW FLOOR WASTE
	NEW U.P.V.C. STORMWATER DRAINAGE PIPE LAID AT 1.0% MIN. FALL (UNO) TO OUTLET IN ACCORDANCE WITH COUNCILS SPECIFICATIONS
	APPROXIMATE POSITION OF EXISTING STORMWATER DRAINAGE PIPE
o dp	DENOTES DOWNPIPE
$\longrightarrow$	DIRECTION OF SURFACE FALL
<b>-</b> ·-·-	BOUNDARY LINE
/	EXISTING FENCE
s	EXISTING SEWER SERVICE
	EXISTING POWER POLE
8	EXISTING GAS METER
*	EXISTING TELECOMMUNICATIONS PIT
<b>₩</b> M	EXISTING STOP VALVE
8	EXISTING SEWER INSPECTION POINT
©	EXISTING BOLLARD
	EXISTING TREE

### NOTES

THE POSITION OF ALL EXISTING SERVICES SHOWN SHOULD BE REGARDED AS APPROXIMATE ONLY AND NOT NECESSARILY COMPREHENSIVE. IT IS THE CONTRACTOR'S RESPONSIBILITY TO DETERMINE THE EXACT SERVICE LOCATIONS AND INFORM ALL AUTHORITIES PRIOR TO ANY EXCAVATION.

DURING CONSTRUCTION, THE STRUCTURE SHALL BE MAINTAINED IN A STABLE CONDITION AND NO PART OF THE STRUCTURE SHALL BE OVER-STRESSED. TEMPORARY STRUCTURES, FORMWORK, FALSEWORK, TEMPORARY BRACING, SHORING AND THE LIKE SHALL BE THE SOLE RESPONSIBILITY OF THE CONTRACTOR.

ALL HANDRAILS, IF REQUIRED, ARE TO ARCHITECT'S LOCATION AND DETAILS AND SHALL COMPLY WITH AS1684.

BENCHMARKS TO BE PROVIDED PRIOR TO COMMENCEMENT OF CONSTRUCTION.

EXISTING CONTOURS ARE SHOWN AT 0.50m INTERVALS.

TREATMENT OF ALL EXPOSED / DISTURBED AREAS TO ARCHITECT'S DETAILS.

DETAIL OF LANDSCAPING IS TO TAKE INTO CONSIDERATION OVERLAND FLOW

ALL FENCES ARE TO BE DETAILED WITH 100mm GAP UNDER OR TO BE NON SOLID FENCES TO ALLOW WATER FLOW.


WHERE SITE IS IN CUT ADJACENT TO SITE BOUNDARY, TOP OF RETAINING WALLS TO BE CONSTRUCTED FLUSH WITH EXISTING SURFACE OF NEIGHBORING PROPERTIES TO AVOID IMPOUNDING WATER ON NEIGHBORING PROPERTIES.



# GROUND FLOOR - STORMWATER DRAINAGE PLAN

### NOT FOR CONSTRUCTION

		\ This drawing i	is the property of			CLIENT	PROJECT	DRAWING STATU	S		SHEET SIZE
σ		Lindsa and must no	ay Dynan ot be retained,	l •	NEWCASTLE	BRANCOURT NOMINEES PTY LTD	MIXED USE DEVELOPMENT		DRAFT	COPY	A1
	SUSTAINABLE	copied or the consent of	used without of the company	Lindsay	5 Newton Street Broadmeadow NSW 2292 Phone - 02 4941 9900 Facsimile - 02 4957 7507		990 HUNTER STREET	DRAFTSMAN	DESIGNER		R SCALE
O         C         18/08/16         M.B.         M.M.         M.M.         RE-ISSUED FOR DA           B         07/04/16         M.M.         M.M.         M.M.         AMENDED FOR DA SUBMISSION	✓ ISO 9001 : 2008 ✓ Endorsed	Member of:	©	Dynan	Email - mail@lindsaydynan.com.au Web - www.lindsaydynan.com.au	GROUND FLOOR	NEWCASTLE WEST, NSW	S.Z. PROJECT REF N	No.	M.M. M.M. DRAWING No.	1:200 REVISION
A 03/03/16 S.Z. M.M. M.M. ISSUED FOR DEVELOPMENT APPLICATION	Quality  Management	CONSULT AUSTRALIA	Copyright Lindsay Dynan	<b>D</b> y 1 10.1 1	Sydney I Perth I Newcastle I Central Coast	STORMWATER DRAINAGE PLAN	TALLVO/COTEL VILOT, TACVV	1212		DA02	C
REV DATE DRN CHK APP DRAWING STATUS	System		as date of issue		Sydney I Fertil I Newcastle I Gentral Coast	STORIVIVATER DRAINAGE PLAIN		1212	.0	DAUZ	

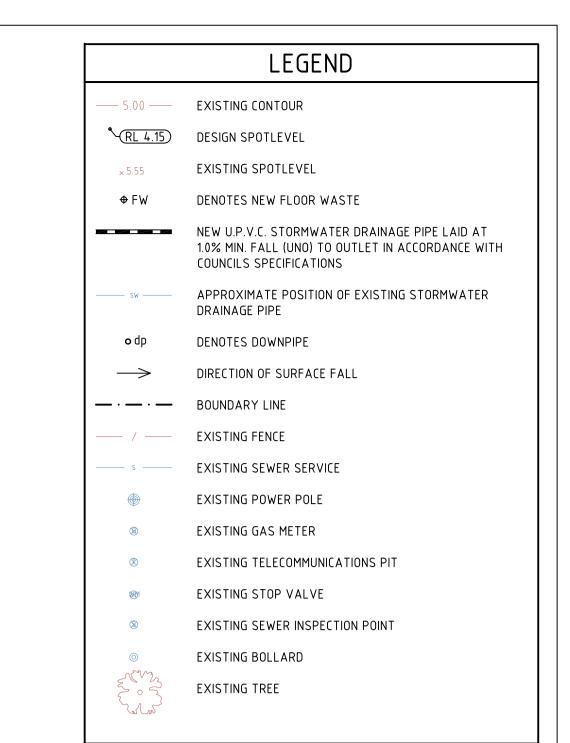

### NOTES

THE POSITION OF ALL EXISTING SERVICES SHOWN SHOULD BE REGARDED AS APPROXIMATE ONLY AND NOT NECESSARILY COMPREHENSIVE. IT IS THE CONTRACTOR'S RESPONSIBILITY TO DETERMINE THE EXACT SERVICE LOCATIONS AND INFORM ALL AUTHORITIES PRIOR TO ANY EXCAVATION.

DURING CONSTRUCTION, THE STRUCTURE SHALL BE MAINTAINED IN A STABLE CONDITION AND NO PART OF THE STRUCTURE SHALL BE OVER-STRESSED. TEMPORARY STRUCTURES, FORMWORK, FALSEWORK, TEMPORARY BRACING, SHORING AND THE LIKE SHALL BE THE SOLE RESPONSIBILITY OF THE CONTRACTOR.

ALL HANDRAILS, IF REQUIRED, ARE TO ARCHITECT'S LOCATION AND DETAILS AND SHALL COMPLY WITH AS1684.

BENCHMARKS TO BE PROVIDED PRIOR TO COMMENCEMENT OF CONSTRUCTION.

EXISTING CONTOURS ARE SHOWN AT 0.50m INTERVALS.

TREATMENT OF ALL EXPOSED / DISTURBED AREAS TO ARCHITECT'S DETAILS.

DETAIL OF LANDSCAPING IS TO TAKE INTO CONSIDERATION OVERLAND FLOW

ALL FENCES ARE TO BE DETAILED WITH 100mm GAP UNDER OR TO BE NON SOLID FENCES TO ALLOW WATER FLOW.

WHERE SITE IS IN CUT ADJACENT TO SITE BOUNDARY, TOP OF RETAINING WALLS TO BE CONSTRUCTED FLUSH WITH EXISTING SURFACE OF NEIGHBORING PROPERTIES TO AVOID IMPOUNDING WATER ON NEIGHBORING



### FIRST FLOOR - STORMWATER DRAINAGE PLAN CARPARKS P5-P9 SIMILAR SCALE 1:200

SNOI							SUSTAINABLE CERTIFICATION	This drawing is Lindsay and must not copied or u the consent o	Dynan t be retained, sed without
SI,	С	18/08/16	м.в.	M.M.	M.M.	RE-ISSUED FOR DA	✓ ISO 9001 : 2008		
ΕV	В	07/04/16	M.M.	M.M.	M.M.	AMENDED FOR DA SUBMISSION	Endorsed Quality	Member of:	©
Я	А	03/03/16	S.Z.	M.M.	M.M.	ISSUED FOR DEVELOPMENT APPROVAL	Management	CONSULT AUSTRALIA	Copyright Lindsay Dynan
	REV	DATE	DRN	СНК	APP	DRAWING STATUS	System		as date of issue

REV DATE DRN CHK APP DRAWING STATUS



NEWCASTLE 5 Newton Street Broadmeadow NSW 2292 Phone - 02 4941 9900 Facsimile - 02 4957 7507 Email - mail@lindsaydynan.com.au Web - www.lindsaydynan.com.au

Sydney I Perth I Newcastle I Central Coast


	CLIENT	
	BRANCOURT NOMINEES PTY LTD	
-	TITLE	
	FIRST FLOOR	


STORMWATER DRAINAGE PLAN

PROJECT MIXED USE DEVELOPMENT 990 HUNTER STREET NEWCASTLE WEST, NSW

DRAWING STATUS				SHEET SIZE
D	RAFT	COP	Υ	A1
DRAFTSMAN	DESIGNE	:R	PROJ MANAGER	SCALE
S.Z.	M.I	M.	M.M.	1:200
PROJECT REF No	١.	DRAWIN	REVISION	
12120	)		DA03	С

NOT FOR CONSTRUCTION

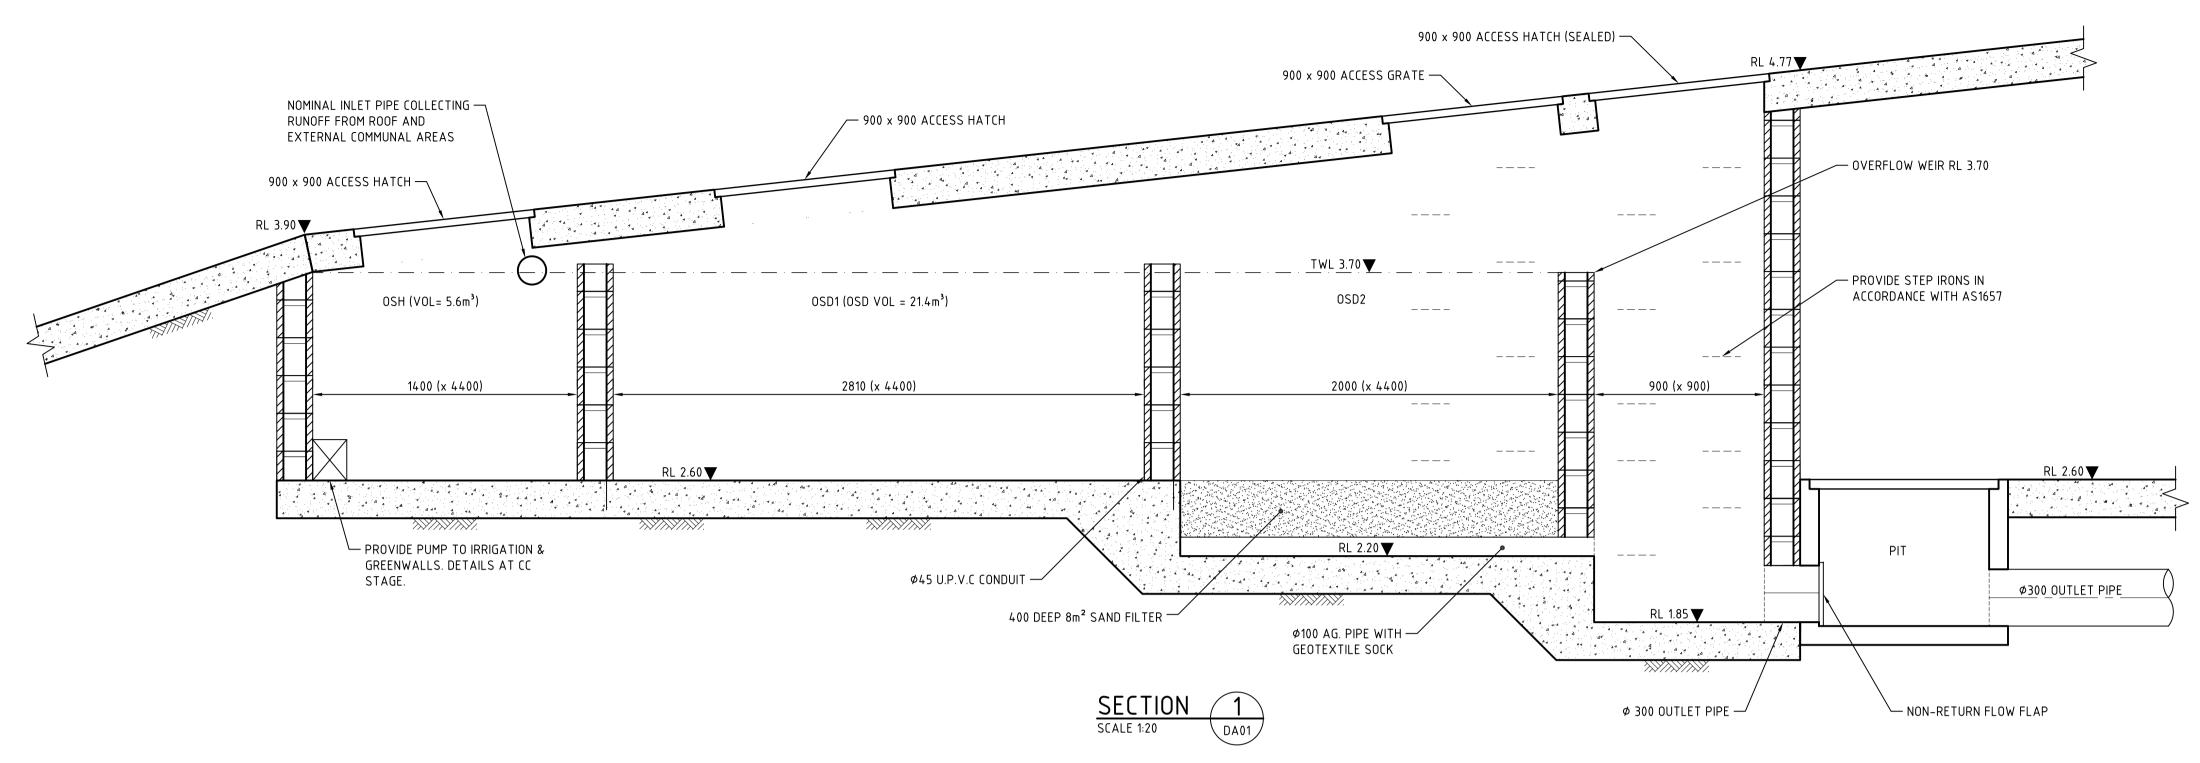

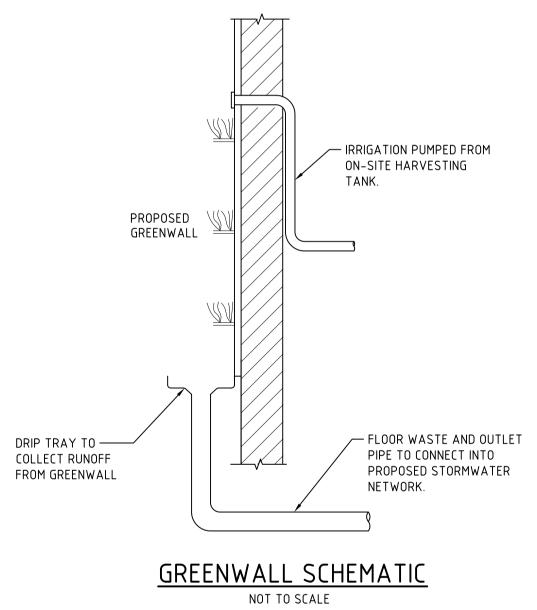

## NOT FOR CONSTRUCTION

			This drawing is the property of	4		CLIENT	PROJECT	DRAWING STATE	JS		SHEET SIZE
σ			Lindsay Dynan and must not be retained,	I in all and	NEWCASTLE	BRANCOURT NOMINEES PTY LTD	MIXED USE DEVELOPMENT		DRAFT C	COPY	A1
0		SUSTAINABLE	the consent of the company	Lindsay	5 Newton Street Broadmeadow NSW 2292 Phone - 02 4941 9900 Facsimile - 02 4957 7507		990 HUNTER STREET	DRAFTSMAN	DESIGNER	PROJ MANAGER	SCALE
<u>σ</u> C 18/08/16 M.B.	M.M. M.M. RE-ISSUED FOR DA	✓ ISO 9001 : 2008			Email - mail@lindsaydynan.com.au	TITLE	- COOTIONTEN CINEET	S.Z.	M.M.	M.M.	1:20
В 07/04/16 M.M.	M.M. M.M. AMENDED FOR DA SUBMISSION	Endorsed	Member of:	<b>Dynan</b>	Web - www.lindsaydynan.com.au		NEWCASTLE WEST, NSW	PROJECT REF	No. DI	RAWING No.	REVISION
α A 03/03/16 S.Z.	M.M. M.M. ISSUED FOR DEVELOPMENT APPLICATION	✓ Quality  ✓ Management	CONSULT AUSTRALIA Copyright Lindsay Dynan	<b>,</b>	Sydney I Perth I Newcastle I Central Coast	STORMWATER DRAINAGE DETAILS		1212	20	DA04	
REV DATE DRN	CHK APP DRAWING STATUS	System	as date of issue		Cyandy 1 1 oran 1 110woddae 1 Ochrai Odda			1212			